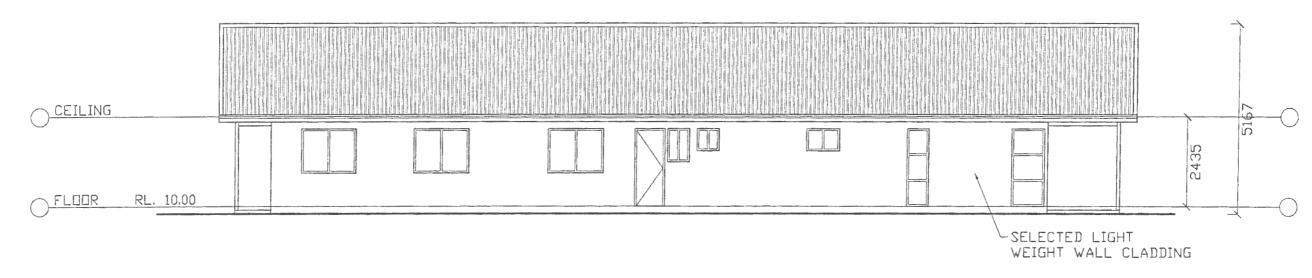


EASTERN ELEVATION

SCALE 1:100



SOUTHERN ELEVATION

SCALE 1:100

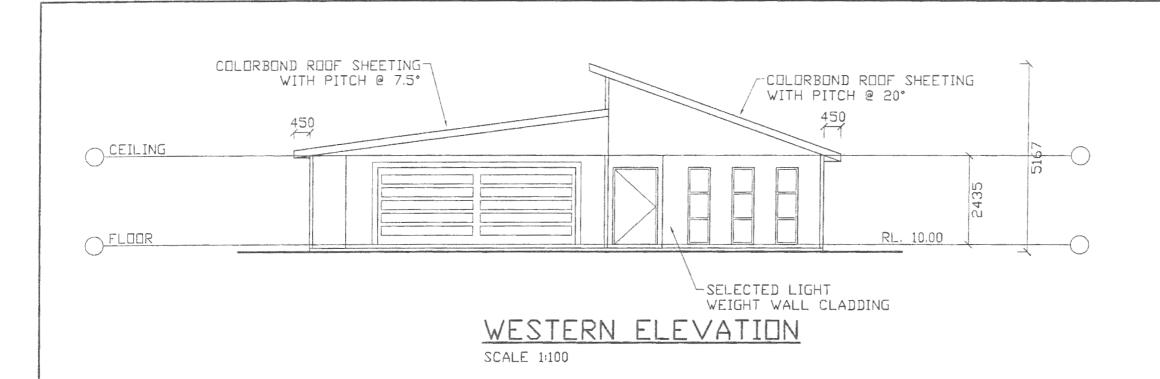
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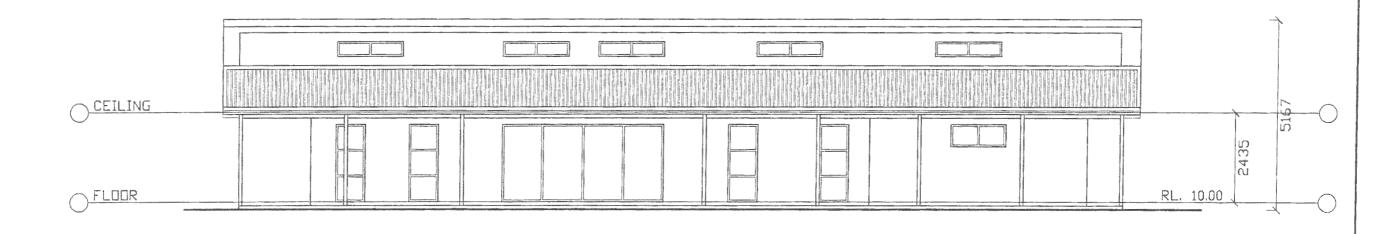
DO NOT SCALE, ONLY REFER TO DIMENSIONS	ALL MEASUREMENTS MUST BE CHECKED BEFORE ANY CONSTRUCTION TAKES PLACE "ON SITE"	1
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CHARLESTOWN HOME PLAN SERVICE 42 JUSTINE AVE, WHITEBRIDGE 2290 PH 49 425 878 MOBILE, 0418 764 257

	LOCATION:	310 PINE BRUSH RD, GLEN WILLIAM	SCALE:	
	PROPOSED:	NEW RESIDENCE		1:100
57	FOR:	D. & A. WOODLAND	DWG NO:	DATE: APR. 2021
/ ر			10621	SHEET: 4 OF 9

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NORTHERN ELEVATION

SCALE 1:100

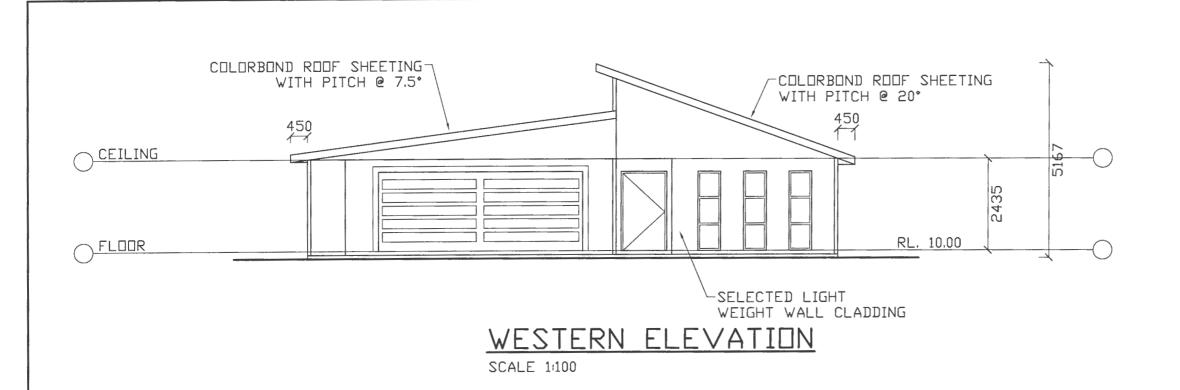
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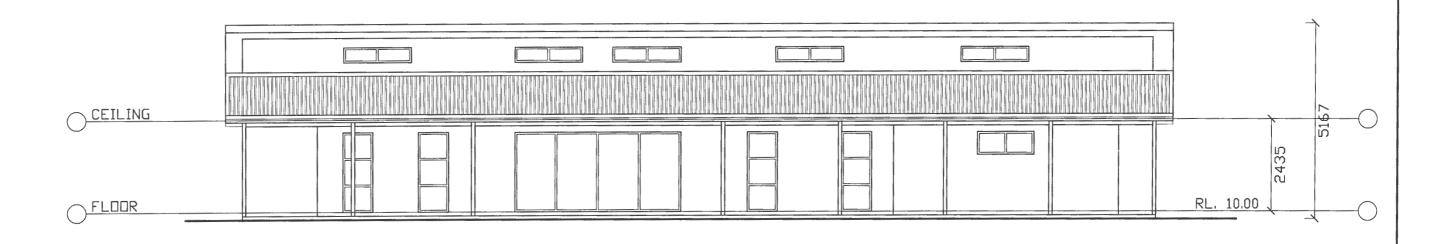
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CHARLESTOWN HOME PLAN SERVICE 42 JUSTINE AVE, WHITEBRIDGE 2290 PH 49 425 878 MOBILE. 0418 764 257

	LOCATION:	310 PINE BRUSH RD, GLEN WILLIAM	SCALE:		
	PROPOSED:	NEW RESIDENCE		1:100	
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			10621	SHEET: 3 OF 9)

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NORTHERN ELEVATION

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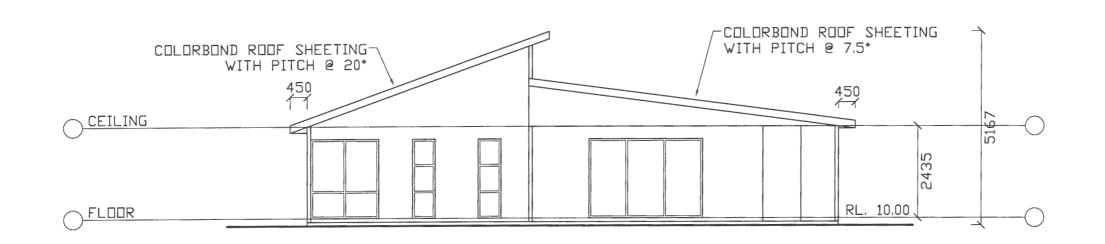


DO NOT SCALE, ONLY REFER TO DIMENSIONS	ALL MEASUREMENTS MUST BE CHECKED BEFORE ANY CONSTRUCTION TAKES PLACE "ON SITE"

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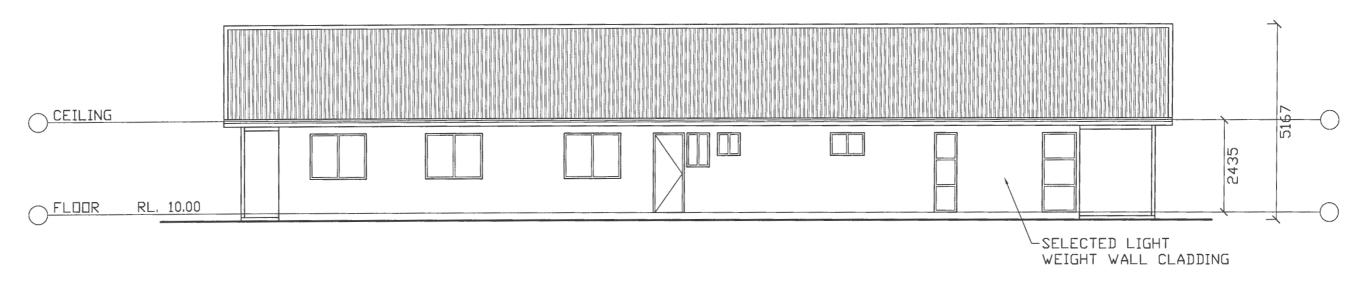
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EASTERN ELEVATION

SCALE 1:100



SOUTHERN ELEVATION

SCALE 1:100

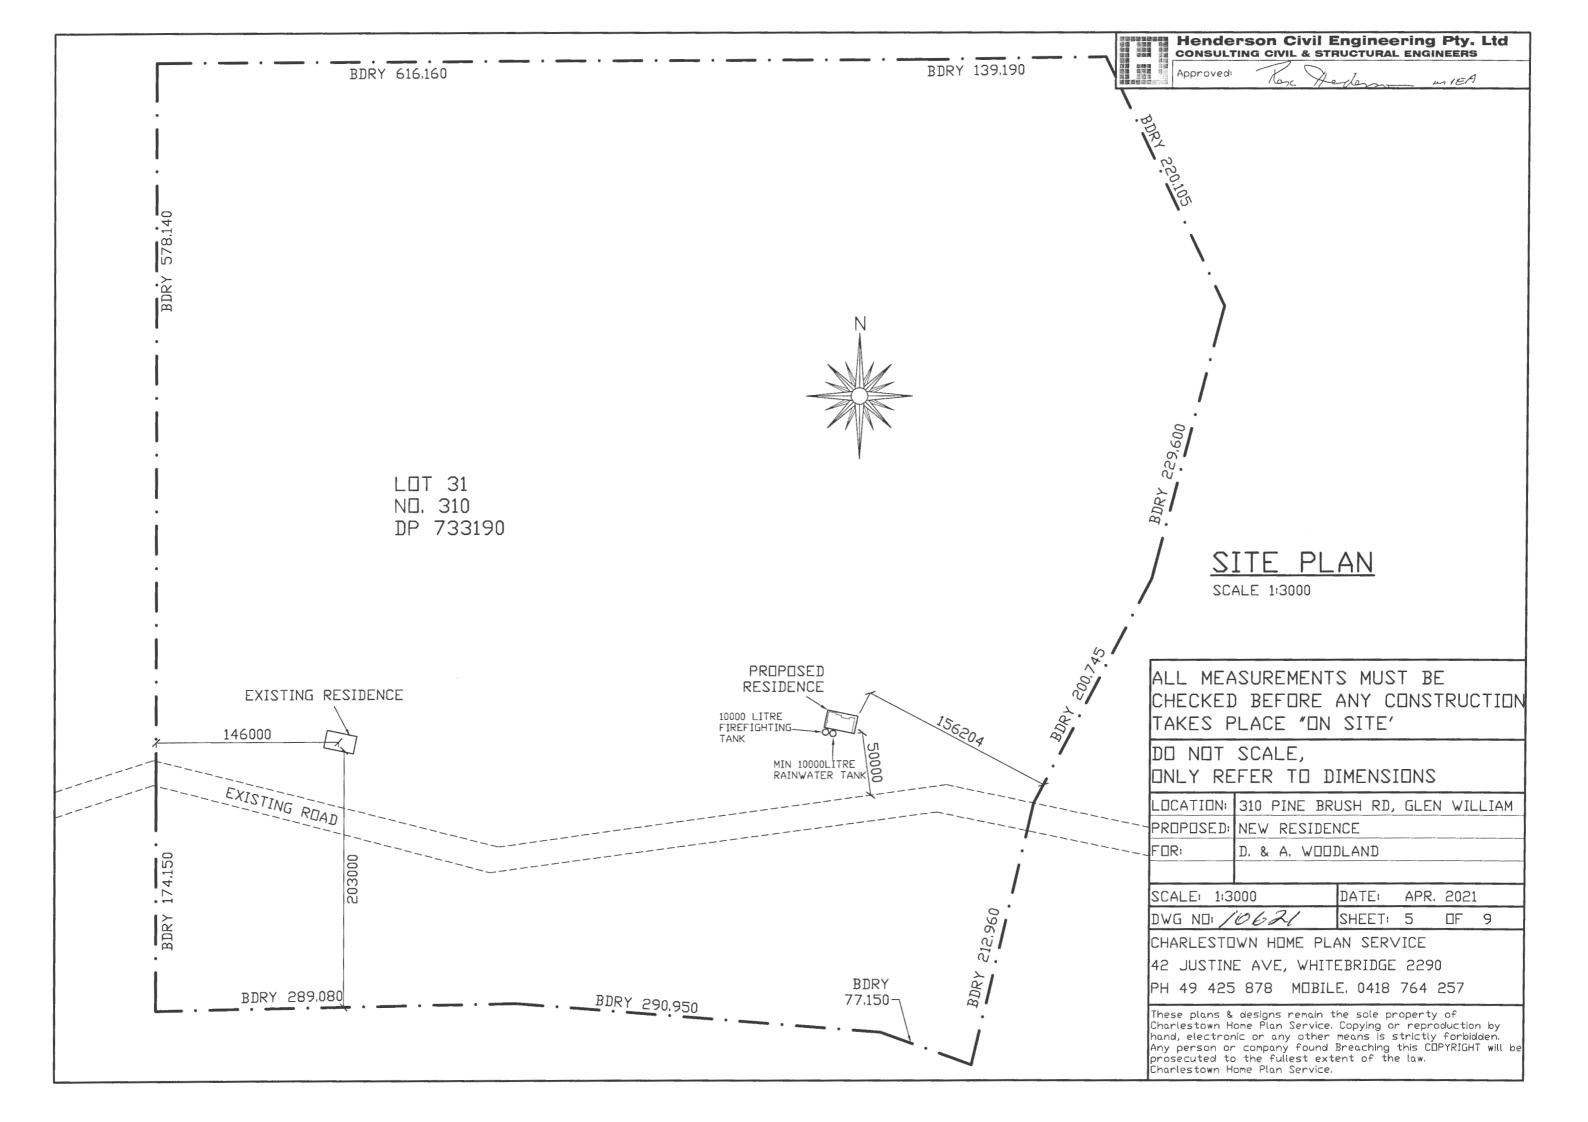
Henderson Civil Engineering Pty. Ltd consulting civil & STRUCTURAL ENGINEERS

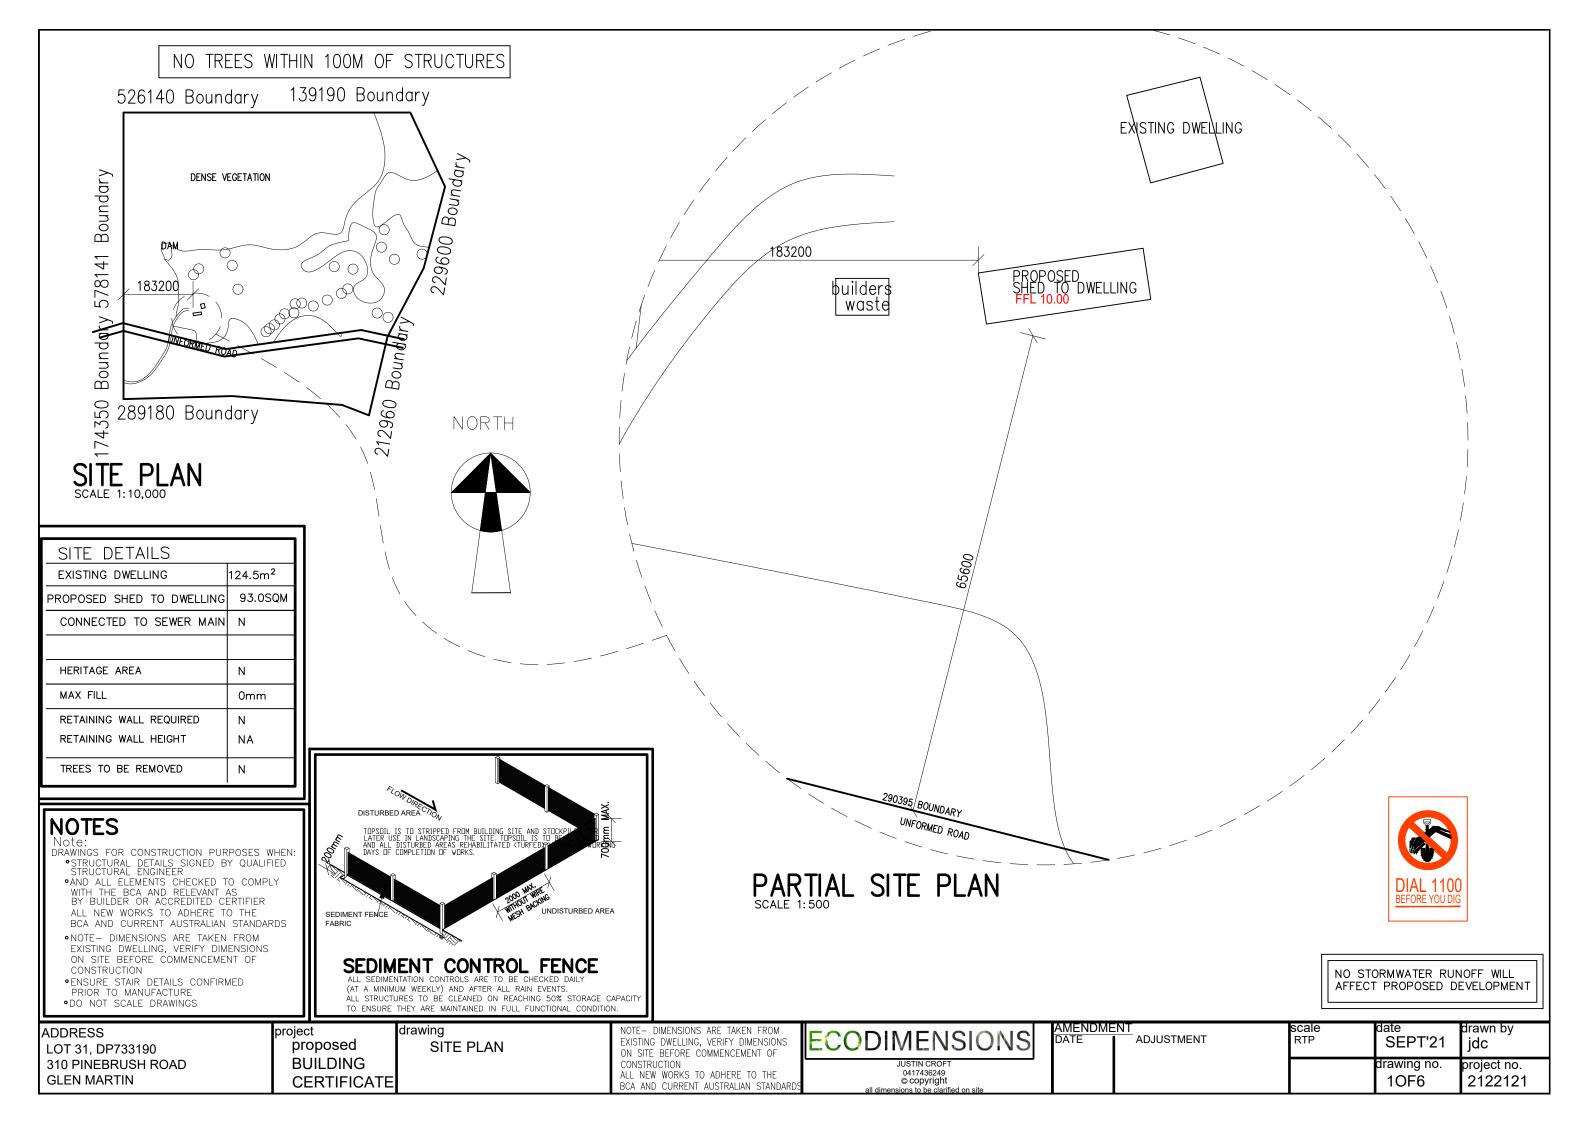
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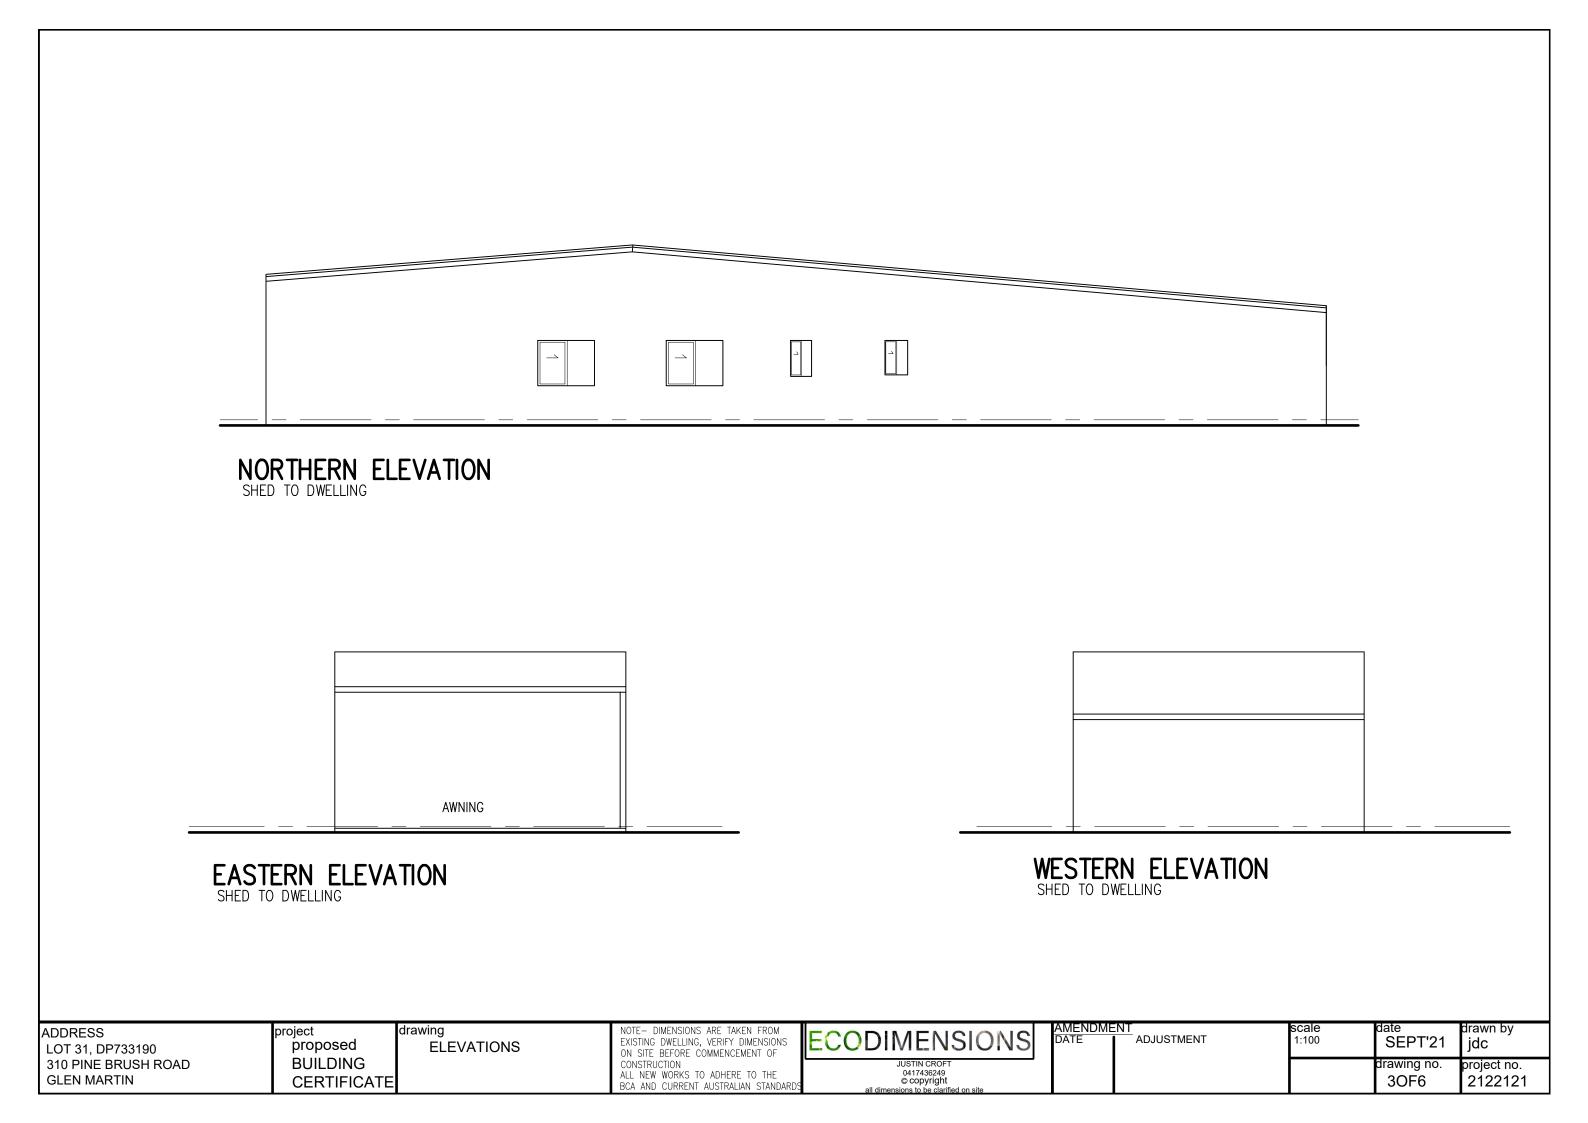
CHARLESTOWN HOME PLAN SERVICE
42 JUSTINE AVE, WHITEBRIDGE 2290
PH 49 425 878 MOBILE. 0418 764 257

JCATION:	310 PINE BRUSH RD, GLEN WILLIAM	SCALE:	
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GENERAL SPECIFICATION ONLY. PLEAS	SE REFER TO CLIENT / CONSULTANT OR AUSTRALIAN STANDARD TO ENSURE ACCURACY
DRAINAGE / PLUMBING	LOCATE ALL EXISTING SERVICES PRIOR TO COMMENCEMENT OF CONSTRUCTION.ALL PLUMBING WORK SHALL COMPLY WITH HUNTER WATER CORPORATION REQUIREMENTS CONNECT ALL SUBSURFACE DRAINS TO EXISTING SYSTEM DOWNPIPES & GUTTERS TO CONNECT TO UPVC PIPE AND DISPENSED TO STORMWATER IN ACCORDANCE WITH COUNCIL'S REQUIREMENTS.INSTALL HOT WATER SERVICE AT AS3500-2013.ALL DRAINAGE WORK TO BE CARRIED OUT BY BY A LICENCED DRAINER.
ELECTRICIAN	ALL WORK TO BE CARRIED OUT TO AS3000-2018.ELECTRICAL INSTALLATION TO HOUSE IS TO BE CARRIED OUT IN ACCORDANCE WITH SAA WIRING RULES. LIGHT FITTINGS, SWITCHES AND OUTLETS TO OWNERS SELECTION AND LOCATION U.N.O
GLAZIER	ALL GLASS THROUGHOUT IS TO BE OF APPROVED MANUFACTURE. GLASS TO BE BACK PUTTIED, SPRIGGED INTO PRIMED OR OIL REBATES AND WEATHER PUTTIED. NEW WINDOWS & DOORS SHALL BE SLIDING ALUMINIUM TO OWNER'S SELECTION TO MATCH STYLE OF EXISTING HOUSE U.N.O PROVIDE APPROVED FLASHING UNDER UNDER EACH WINDOW FRAME.
PAINTER WHERE REQUIRED	ALL PAINT COLOURS & FINISHES TO OWNER'S SELECTION ALL PAINT TO BE SUPPLIED BY A REPUTABLE MANUFACTURER. ALL PAINT TO BE APPLIED IN ACCORDANCE WITH MANUFACTURER'S SPECIFICATION ALL SURFACES SHALL BE PREPARED PROPERLY.
GENERAL WHERE REQUIRED	DAMPCOURSE ON ALL BRICKWORK AT A LEVEL NOT HIGHER THAN THE BOTTOM OF FLOOR BEARERS, PROVIDE A CONTINUOUS RUN OF APPROVED DAMPCOURSE MATERIAL TO FULL WIDTH OF WALL THICKNESS AND TO ENGAGED PIERS AND PLACE UNDER ALL ANT CAPPING. ANTCAPS CONTINUOUS ANT CAPPING SHALL BE PROVIDED AT LEVEL OF UNDERSIDE OF BEARERS, OVER ALL FOUNDATION WALLS AND PIERS, FENDER WALLS ETC. ANT CAPPING TO BE OF AN APPROVED MATERIAL. SEDIMENT & EROSION CONTROL PROVIDE SILT FENCE AROUND COMPLETE SITE. PROVIDE 1000 WIDE CONSTRUCTION EXIT TO CONTAIN POLLUTED WATER. RUBBISH CONTROL 1800 SQUARE x 1200 HIGH RUBBISH ENCLOSURE CONSTRUCTED OF 1800 HIGH STAR PICKETS, 1200
TILELAYER WHERE REQUIRED	COVER FLOOR OF BATHROOM, TOILETS AND LAUNDRY AND OTHERS AREAS INDICATED ON FIX TILES TO SURFACES OVER SUITABLE WATERPROOFED SHEET MATERIAL WITH APPROVED ADHESIVE PLAN WITH SELECTED TILES SET TO AN APPROVED PLAN. WHEN FIXING TO BRICKWORK USE 3:1 SAND/CEMENT
TIMBER	ALL TIMBER CONSTRUCTION TO BE IN ACCORDANCE WITH AS 1684.2-2010 'NATIONAL TIMBER FRAMING CODE' ALL WORKMANSHIP & MATERIALS SHALL COMPLY WITH SAA TIMBER STRUCTURES CODE AS1720 AND SAA TIMBER FRAMING CODE AS1684 AS APPLICABLE TIMBER SHALL BE FREE OF DEFECTS AT JOINTS
DESIGN WINDSPEED	(IN ACCORDANCE WITH AS1170 PART-WIND LOAD FOR HOUSING) WIND CLASSIFICATION (FROM TABLE 1.1, NSW TIMBER FRAMING CODE) NOTE: MINIMUM 2 BRACING UNITS EACH EXTERNAL WALL BRACING LOCATIONS MAY BE VARIED PROVIIDING MINIMUM NUMBERS ARE MAINTAINED. TYPE A OR TYPE B IN ACCORDANCE WITH AS1684 OR NSW TIMBER FRAMING MANUAL.
CONCRETE	ALL WORKMANSHIP AND MATERIALS SHALL BE IN ACCORDANCE WITH AS 3600, CONCRETE QUALITY SHALL BE AS FOLLOWS:— TWO (2) TRANSVERSE WIRES PLUS 30mm, TRENCH MESH BAR SPLICE MIN 500mm, AT 'T' INTERSECTIONS BARS ARE TO CONTINUE ACROSS INTERSECTION. AT 'L' BARS ARE TO BE BENT AND LAPPED 500mm, INTERSECTIONS OUTER.CURING COMPOUND IS TO BE APPLIED TO SLABS WITHIN 2 HOURS OF FINISHING, ALL CONCRETE IS TO BE MECHANICALLY VIBRATED.CONCRETE SIZES SHOWN DO NOT INCLUDE THICKNESS OF APPLIED FINISHES. ALL CONCRETE TO BE PLACED IN ACCORDANCE WITH SECTION 19 OF AS 3600, REINFORCEMENT SHALL COMPLY WITH:— AS 1304 — TRENCH MESH AND FABRIC
	AS 1302 — REINFORCING BARS. EXPOSURE CLASSIFICATION TO AS 3600 CONCRETE SURFACES IS:—
FOUNDATIONS	FOOTINGS HAVE BEEN DESIGNED TO ENGINEERS REQUIREMENTS. TO AS 2870 2011. FURTHER GEOTECHNICAL EVIDENCE MAY LEAD TO AMENDMENTS TO FOOTING REQUIREMENTS. FOOTINGS HAVE BEEN DESIGNED FOR THE FOLLOWING ALLOWABLE BEARING PRESSURES:— FOUNDATION MATERIAL SHALL BE APPROVED FOR THIS PRESSURE BEFORE PLACING CONCRETE IN FOOTINGS. ALL FOOTINGS TO BE FOUNDED INTO NATURAL GROUND TO THE SATISFACTION OF THE SUPERVISING ENGINEER. AREA BENEATH FOUNDATIONS TO BE CLEAR OF ALL ORGANIC MATERIAL. ENGINEER MAY REQUIRE EDGE BEAMS TO BE DEEPENED AND/OR PIERING AFTER INSPECTION OF EXCAVATION. FOR NORMAL GARDEN AND SITE CONDITIONS. OWNERS RESPONSIBILITIES
BRICKWORK where required	ALL MASONRY CONSTRUCTION AND MATERIALS SHALL BE IN ACCORDANCE WITH AS 3700. BRICKS USED IN LOAD BEARING WALLS SHALL HAVE A MINIMUM COMPRESSION STRENGTH OF 12 MPg. MORTAR SHALL BE CLASSIFICATION M3 AND SHALL BE FRESHLY PREPARED AND COMPOSED OF CEMENT: LIME: SAND IN THE RATIO OF 1: 1: 6 AND HAVE A MINIMUM COMPRESSIVE STRENGTH OF 2.8 MPg AT 28 DAYS. MORTAR BED THICKNESS SHALL NOT EXCEED 10mm. WALL TIES SHALL BE MANUFACTURED OF STAINLESS STEEL AND BE PLACED AS FOLLOWS: (A) IN GENERAL WORK @ 600 cts IN EACH DIRECTION. (B) ADJACENT TO LATERAL SUPPORTS, CONTROL JOINTS AND OPENINGS @ 300 cts. WHERE SLABS OR BEAMS PROVIDE 15mm WIDE CONTROL JOINTS IN BRICKWORK AT 7000mm MAXIMUM CENTRES. BEAR INTO MASONRY THE TOP COURSE SHALL BE LEVEL, SMOOTH AND COVERED WITH TWO(2) LAYERS OF PRE— CREASED IRON SLIP JOINT OR OTHER APPROVED MATERIAL MASONRY WALLS SHALL BE FIXED TO ADJACENT ELEMENT WITH STAINLESS STEEL TIES TO THE APPROVAL OF THE ENGINEER.

ADDRESS
LOT 31, DP733190
310 PINEBRUSH ROAD
GLEN MARTIN

project proposed BUILDING CERTIFICATE

drawing SPECIFICATIONS NOTE— DIMENSIONS ARE TAKEN FROM
EXISTING DWELLING, VERIFY DIMENSIONS
ON SITE BEFORE COMMENCEMENT OF
CONSTRUCTION
ALL NEW WORKS TO ADHERE TO THE
BCA AND CURRENT AUSTRALIAN STANDARDS

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<u>//ENDMENT</u>	
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